

COPPER CREEK ELEMENTARY SCHOOL

MPR ROOF REPLACEMENT

Amphitheater Public Schools


November 2021

100% Construction Documents




Breckenridge
g r o u p
a r c h i t e c t s
p l a n n e r s

Job No. 17.14.72

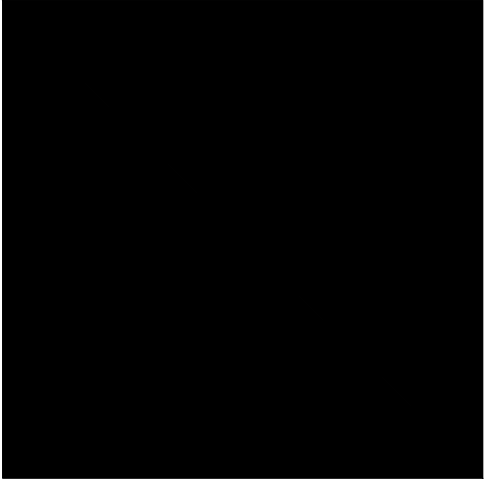

Breckenridge
g r o u p
a r c h i t e c t s
p l a n n e r s
1735 e ft. lowell rd. #12
tucson arizona 85719
5 2 0 . 8 8 2 . 9 9 4 4

Amphitheater Public Schools
Copper Creek Elementary School
MPR Roof Replacement
SFB Project No.: BRG-DSGN-00357

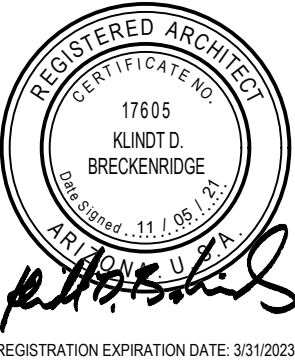

PROJECT NO:
17.14.72

DATE:
OCTOBER 2021

REVISION SCHEDULE:		
DATE	DESCRIPTION	ISSUED TO
12/16/21	SFB COMMENTS	

DRAWN BY: SC
CHECKED BY: KDB

THIS DRAWING IS NOT TO BE USED FOR
CONSTRUCTION PURPOSES UNTIL SEALED AND SIGNED BY
ARCHITECTS OF BRECKENRIDGE GROUP INC., ARCHITECTS /
PLANNERS, OR DESIGNATED CONSULTANTS.
DRAWINGS ARE COPYRIGHTED BY BRECKENRIDGE GROUP
ARCHITECTS / PLANNERS. ANY REPRODUCTION OR REUSE
WITHOUT WRITTEN PERMISSION IS STRICTLY FORBIDDEN. ®


Cover Sheet

G1.0

ABBREVIATIONS

A.B.C.	ANCHOR BOLT	N.I.C.	NOT IN CONTRACT
A.C.	AGGREGATE BASE COURSE	NOM.	NOMINAL
A.C.J.	AIR CONDITIONING	N.O.	NUMBER
A.D.	ADJUNCT	N.T.S.	NOT TO SCALE
A-E C	ACID ETCHED CONCRETE		
AFF	ABOVE FINISH FLOOR	O/	OVER OR ON
ALLOW	ALLOWANCE	O.C.	ON CENTER
ALT	ALTERNATE	O.D.	OUTSIDE DIAMETER
ALUM	ALUMINUM	O.F.	OUTSIDE FACE
AMP	AMPERE	P.B.	PUBLIC
A.P.	ACCESS PANEL	O.F.C.I.	OWNER FURNISHED CONTRACTOR INSTALLED
A.T.	ACOUSTICAL TILE	O.F.O.J.	OWNER FURNISHED
@	AT		OWNER INSTALLED
AUTO	AUTOMATIC	OPNG.	OPENING
		OPP.	OPPOSITE
BD	BOARD		
B.L.	BUILDING LINE	P	PAVEMENT
BLDG.	BUILDING	P.C.	PULL CHAIN
BLKG.	BLOCKING	PE	PIECE
BH.	BEAM	PERP.	PERPENDICULAR
BOT.	BOTTOM	PL	PLATE
BEARING	BEARING	PLAS	PLASTER
B.SMT.	BASEMENT	PL.GL.	PLATE GLASS
BTWN.	BETWEEN	PLAS. LAM.	PLASTIC LAMINATE
B.U.	BUILT UP	PLYWD.	PLYWOOD
		PNL.	PANEL
CAB	CABINET	PR.	PAIR
C.B.	CATCH BASIN	PROJ.	PROJECT
C.B.D.	CEMENT BOARD	PT	PRESSURE TREATED
CEM.	CEMENT	PTN.	PARTITION
CEM. PLAS.	CEMENT PLASTER	PUB.	PUBLIC
CER.	CERAMIC	PURL.	PURLIN
C.F.C.I.	CONTRACTOR FURNISH CONTRACTOR INSTALL	PVC	POLYVINYL CHLORIDE
		PTD.	PAINTED
CFM	CUBIC FEET PER MINUTE	Q	PHASE
	CHANNELS		
C.I.	CAST IRON	Q.T.	QUARRY TILE
CIR.	CIRCUIT		
C.J.	CONTROL JOINT		
C.L.	CENTER LINE	R	RISER
C.LG.	CEILING	RAD.	RADIUS
CM.	CULTURED MARBLE	R.A.	RETURN AIR
CMU	CONCRETE MASONRY UNIT	RCPT.	RECEPTACLE
C.O.	CLEAN OUT	R.D.	ROOF DRAIN
COL.	COLUMN	REC.	RECESSED
COMB.	COMBINATION	REG.	REGISTER
CONC.	CONCRETE	REINF.	REENFORCEMENT
CONST.	CONSTRUCTION	REQ'D.	REQUIRED
CONT.	CONTINUOUS	REV.	REVISION
CPT.	CARPET	RFG.	ROOFING
CSK.	COUNTERSINK	RM.	ROOM
C.T.	CERAMIC TILE	R.O.	ROUGH OPENING
C.W.	COLD WATER	S.C.	SOLID CORE
		SCWD.	SOLID CORE WOOD DOOR
		SCHED.	SCHEDULE
DET.	DETAIL	SECT.	SECTION
D.F.	DRINKING FOUNTAIN	SQ. FT.	SQUARE FOOT
DM.	DIMENSION	SH.	SHEET
DN.	DOWN	SHL.	SHOULDER
DO	DOOR	SHL.	SHOULDER
DR.	DOOR	SLV	SHORT LEG VERTICAL
DOWN	DOWN SPOUT	S.M.	SHEET METAL
DWG.	DRAWING	SPECS.	SPECIFICATIONS
		SPKR.	SPEAKER
EA.	EACH	SQ.	SQUARE
E.F.	EACH FACE	S.S.	SERVICE SINK
E.J.	EXPANSION JOINT	S.S.TL.	STAINLESS STEEL
ELEC.	ELECTRICAL	STD.	STANDARD
ELEV.	ELEVATION	STOR.	STORAGE
ENT.	ENTRANCE	STL	STEEL
EQ.	EQUAL	STRUCT.	STRUCTURAL
EQUIP.	EQUIPMENT	SUSP. CLG.	SUSPENDED CEILING
E.W.	EACH WAY		
EW	ELECTRIC WATER COOLER	T	TREAD
EXH.	EXHAUST	T&G	TONGUE AND GROOVE
EXIST'G.	EXISTING	TEL.	TELEPHONE
EXP.	EXPANSION	TH.	THICK
EXT.	EXTERIOR	THR.	THRESHOLD
(E)	EXISTING	T.O.B.	TOP OF BEAM
		T.O.C.	TOP OF CURB
F.D.	FLOOR DRAIN	T.O.F.	TOP OF FOOTING
FCO	FLOOR CLEAN OUT	T.O.M.	TOP OF MASONRY
FDN.	FOUNDATION	T.O.W.	TOP OF WALL
F.E.	FIRE EXTINGUISHER	T.S.	TUBE STEEL
FEC	FIRE EXTINGUISHER CABINET	T.T.B.	TELEPHONE TERMINAL BOARD
F.F.E.	FINISH FLOOR ELEVATION	TV	TELEVISION
FIN.	FINISH	TV.	TYPICAL
FLSH.	FLASHING		
FLR.	FLOOR	U.N.O.	UNLESS NOTED OTHERWISE
FLUOR.	FLUORESCENT		
F.S.	FLOOR SINK	V	OR VENT
FT.	FEET	VCP	VITRIFIED CLAY PIPE
FTG.	FOOTING	VCT	VINYL COMPOSITION TILE
FURR.	FURRING	VERT.	VERTICAL
		VTR	VENT THRU ROOF
GA.	GAUGE		
GALV.	GALVANIZED	W/	WITH
G.FRC	GLASS FIBER	W.C.	WATER CLOSET
	REINFORCED CONCRETE	WCO	WALL CLEAN OUT
GLB	GLUE LAMB BEAM	W.J.	WROUGHT IRON
GWB	GYPSSUM WALL BOARD	WRGWB	WATER RESISTANT - GYPSSUM WALL BOARD
			WAINSCOT
H.B.	HOSE BIB	WSCT.	WAINSCOT
H.C.	HOLLOW CORE	WT.	WEIGHT
HDW.	HARDWARE	W.W.M.	WELDED WIRE MESH
H.M.	HOLLOW METAL	WD.	WOOD
HORIZ.	HORIZONTAL	WDW.	WINDOW
H.P.	HORSEPOWER	W.P.	WATER PROOF
HT.	HEIGHT	W.R.	WATER RESISTANT
H.W.	HOT WATER		
HWR	HOT WATER RETURN		
ICC.	INTEGRAL COLOR CONCRETE		
I.D.	INSIDE DIAMETER		
I.F.	INSIDE FACE		
INFO.	INFORMATION		
INS.	INSULATION		
INT.	INTERIOR		
J.B.	JUNCTION BOX		
J.C.	JANITOR'S CLOSET		
JST.	JOIST		
JT.	JOINT		
LAV	LAVATORY		
MAS.	MASONRY		
MAT.	MATERIAL		
MAX.	MAXIMUM		
M.B.	MACHINE BOLT		
MCJ	MASONRY CONTROL JOINT		
MECH.	MECHANICAL		
MEMB.	MEMBRANE		
MFG.	MANUFACTURER		
M.H.	MANHOLE		
MIN.	MINIMUM		
MISC.	MISCELLANEOUS		
ML	METAL LATH		
MO	MASONRY OPENING		
MTD.	MOUNTED		
MTL.	METAL		
MULL.	MULLION		

SYMBOLS LEGEND

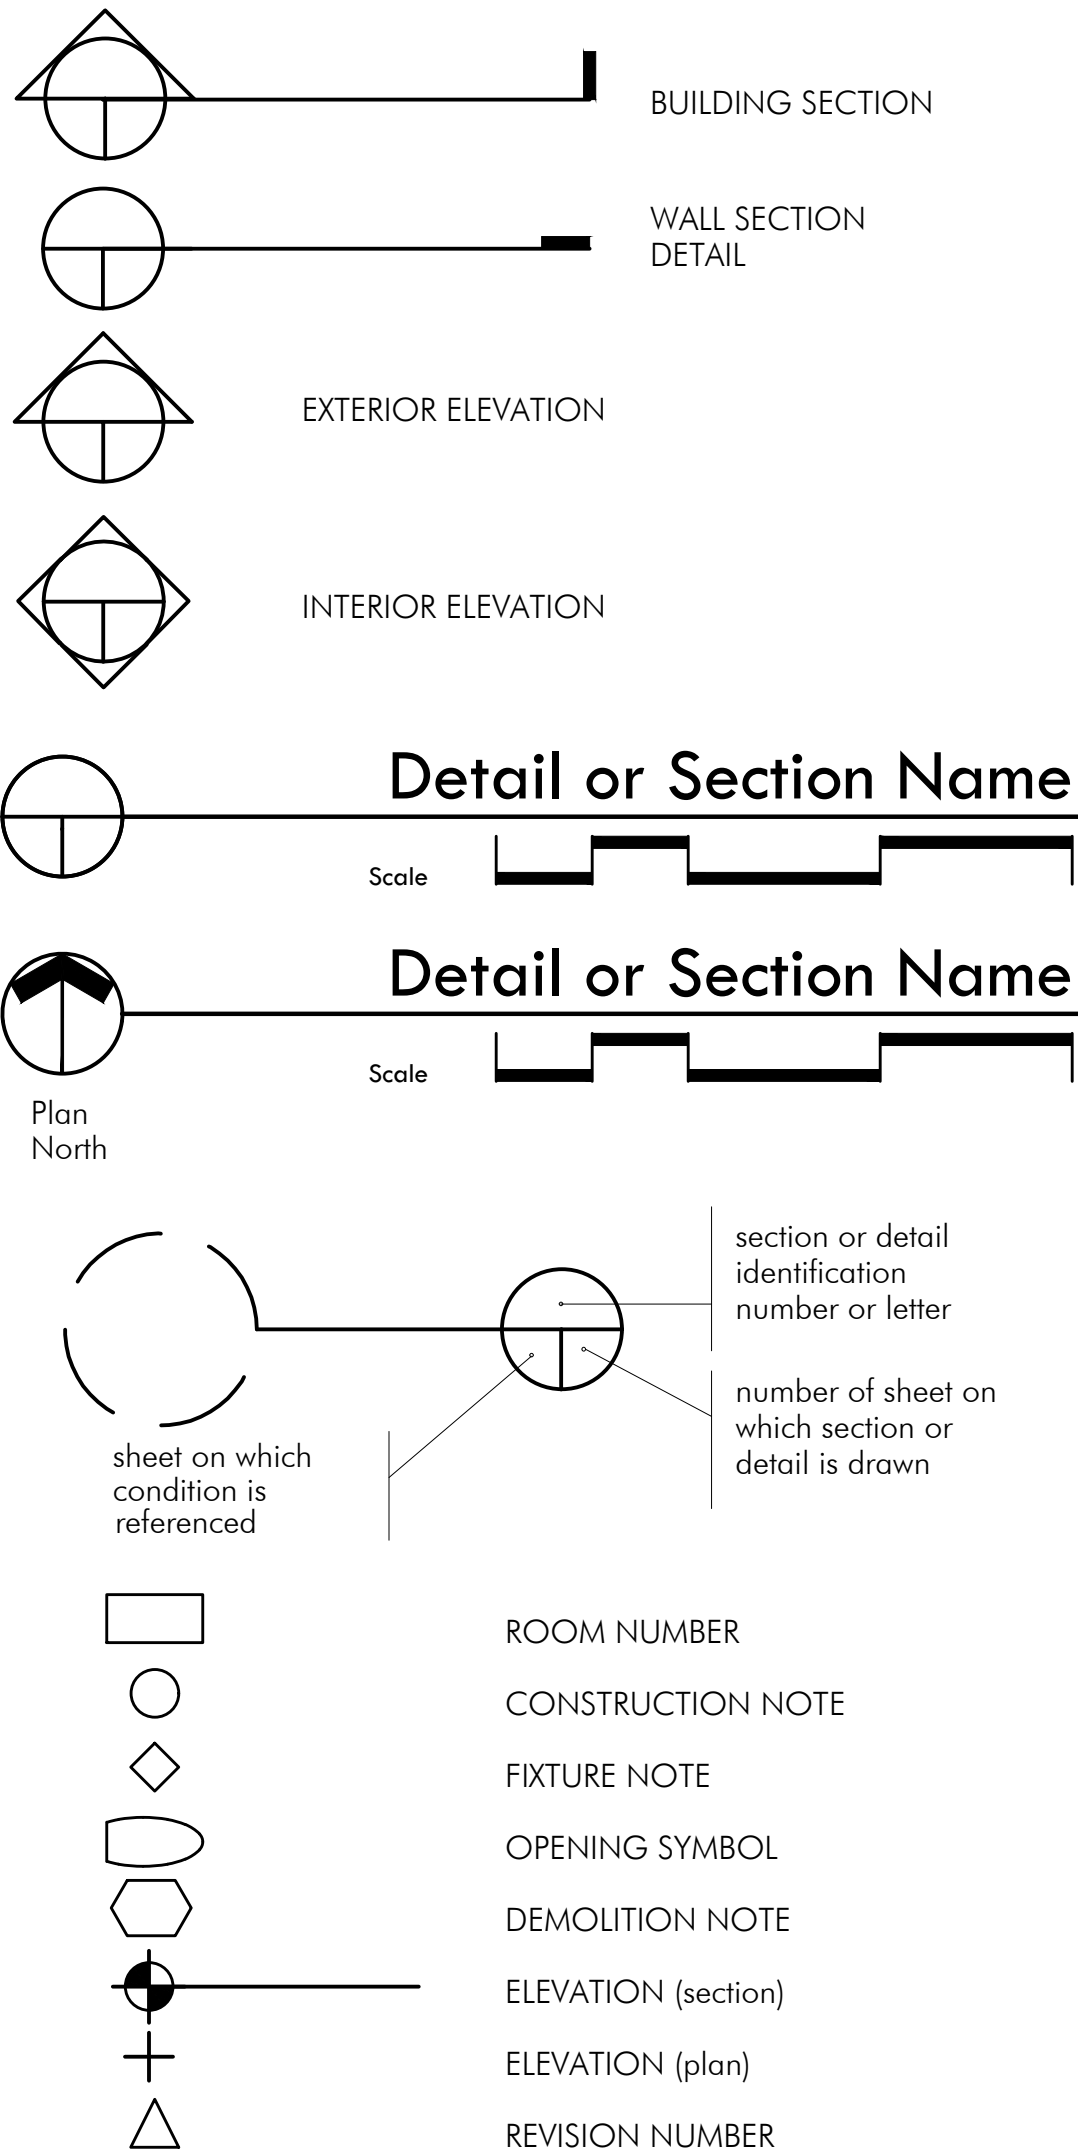

MATERIALS

EXISTING WALL REMOVED

EXISTING WALL TO REMAIN

NEW WALL (REFER TO KEYNOTE)

EARTH

BASE COURSE

CONCRETE

CONCRETE MASONRY UNITS

BRICK

WOOD STUDS

ROUGH FRAMING

BLOCKING

FINISH LUMBER

PLYWOOD

METAL STUDS (SECTION)

STRUCTURAL STEEL

BATT INSULATION

RIGID INSULATION

CEMENT PLASTER

GYPSUM WALL BOARD


CEILING TILE

ASPHALT

WELDED WIRE MESH

FULL HEIGHT INSULATION

STRUCTURAL STUDS

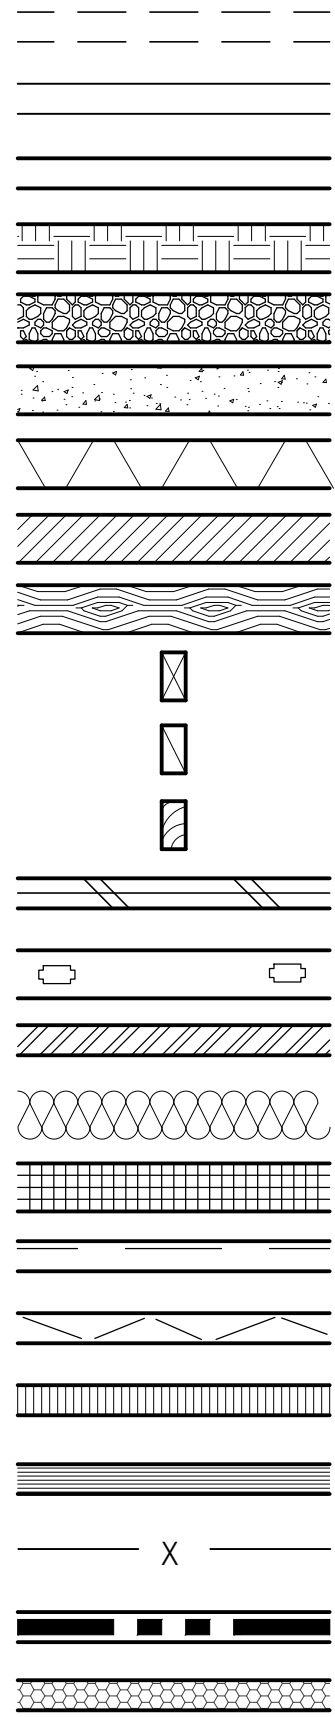

PROJECT TEAM

Project Address

COPPER CREEK ELEMENTARY SCHOOL
11620 N. COPPER SPRING PLACE
ORO VALLEY, AZ 85737

Owner

AMPHITHEATER PUBLIC SCHOOLS
701 W. WETMORE ROAD
TUCSON, AZ 85705

Owner Contact

TRACY HILL
CONSTRUCTION PROJECT MANAGER
AMPHITHEATER PUBLIC SCHOOLS
520.696.5153

Architect

BRECKENRIDGE GROUP, INC.
1735 E. FORT LOWELL ROAD #12
TUCSON, AZ 85712

EDGARDO PARRA
PROJECT MANAGER
520.882.9944

Structural Engineer

STRUCTURAL CONCEPTS INC.
8230 E. BROADWAY, SUITE W-7
TUCSON, AZ 85710

JENNIFER PATRONSKI, PE, SE
PRINCIPAL
520.721.2324

Contractor

TBD



Campus Map


N.T.S.

INDEX

SHEET NUMBER	SHEET TITLE
G1.0	COVER SHEET
G2.0	GENERAL INFORMATION
	<u>ARCHITECTURAL</u>
A1.1	DEMOLITION ROOF PLAN
A2.1	ROOF PLAN
A3.1	DETAILS

APPLICABLE CODES

1. PROJECT HAS BEEN DESIGNED TO COMPLY WITH 2018 INTERNATIONAL BUILDING CODE (IBC) AND 2010 ADA STANDARDS FOR ACCESSIBLE DESIGN.

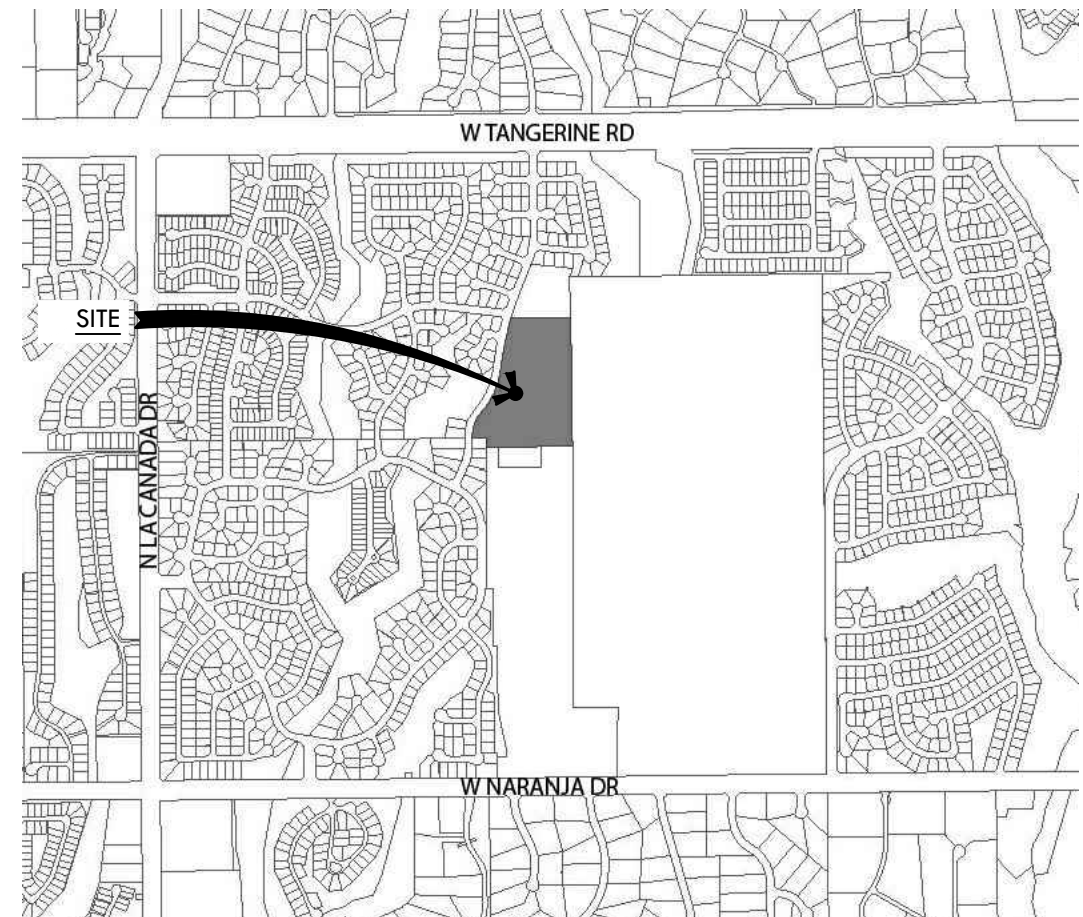

Location Map

N.T.S.

Amphitheater Public Schools
Copper Creek Elementary School
MPR Roof Replacement
SFB Project No.: BRG-DSGN-00357



REGISTRATION EXPIRATION DATE: 3/31/2023

PROJECT NO:
17.14.72

DATE: -OCTOBER 2021

[illegible]

DRAWN BY: SC
CHECKED BY: KDE

THIS DRAWING IS NOT TO BE USED FOR CONSTRUCTION PURPOSES UNTIL SEALED AND SIGNED BY ARCHITECTS OF BRECKENRIDGE GROUP INC., ARCHITECTS / PLANNERS, OR DESIGNATED CONSULTANTS.



DRAWINGS ARE COPYRIGHTED BY BRECKENRIDGE GROUP
ARCHITECTS / PLANNERS. ANY REPRODUCTION OR REUSE
WITHOUT WRITTEN PERMISSION IS STRICTLY FORBIDDEN. ©

General Information

G2.0

CHECKED BY: _____
DRAWN BY: _____

CHECKED BY:
DRAWN BY:

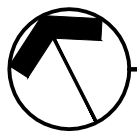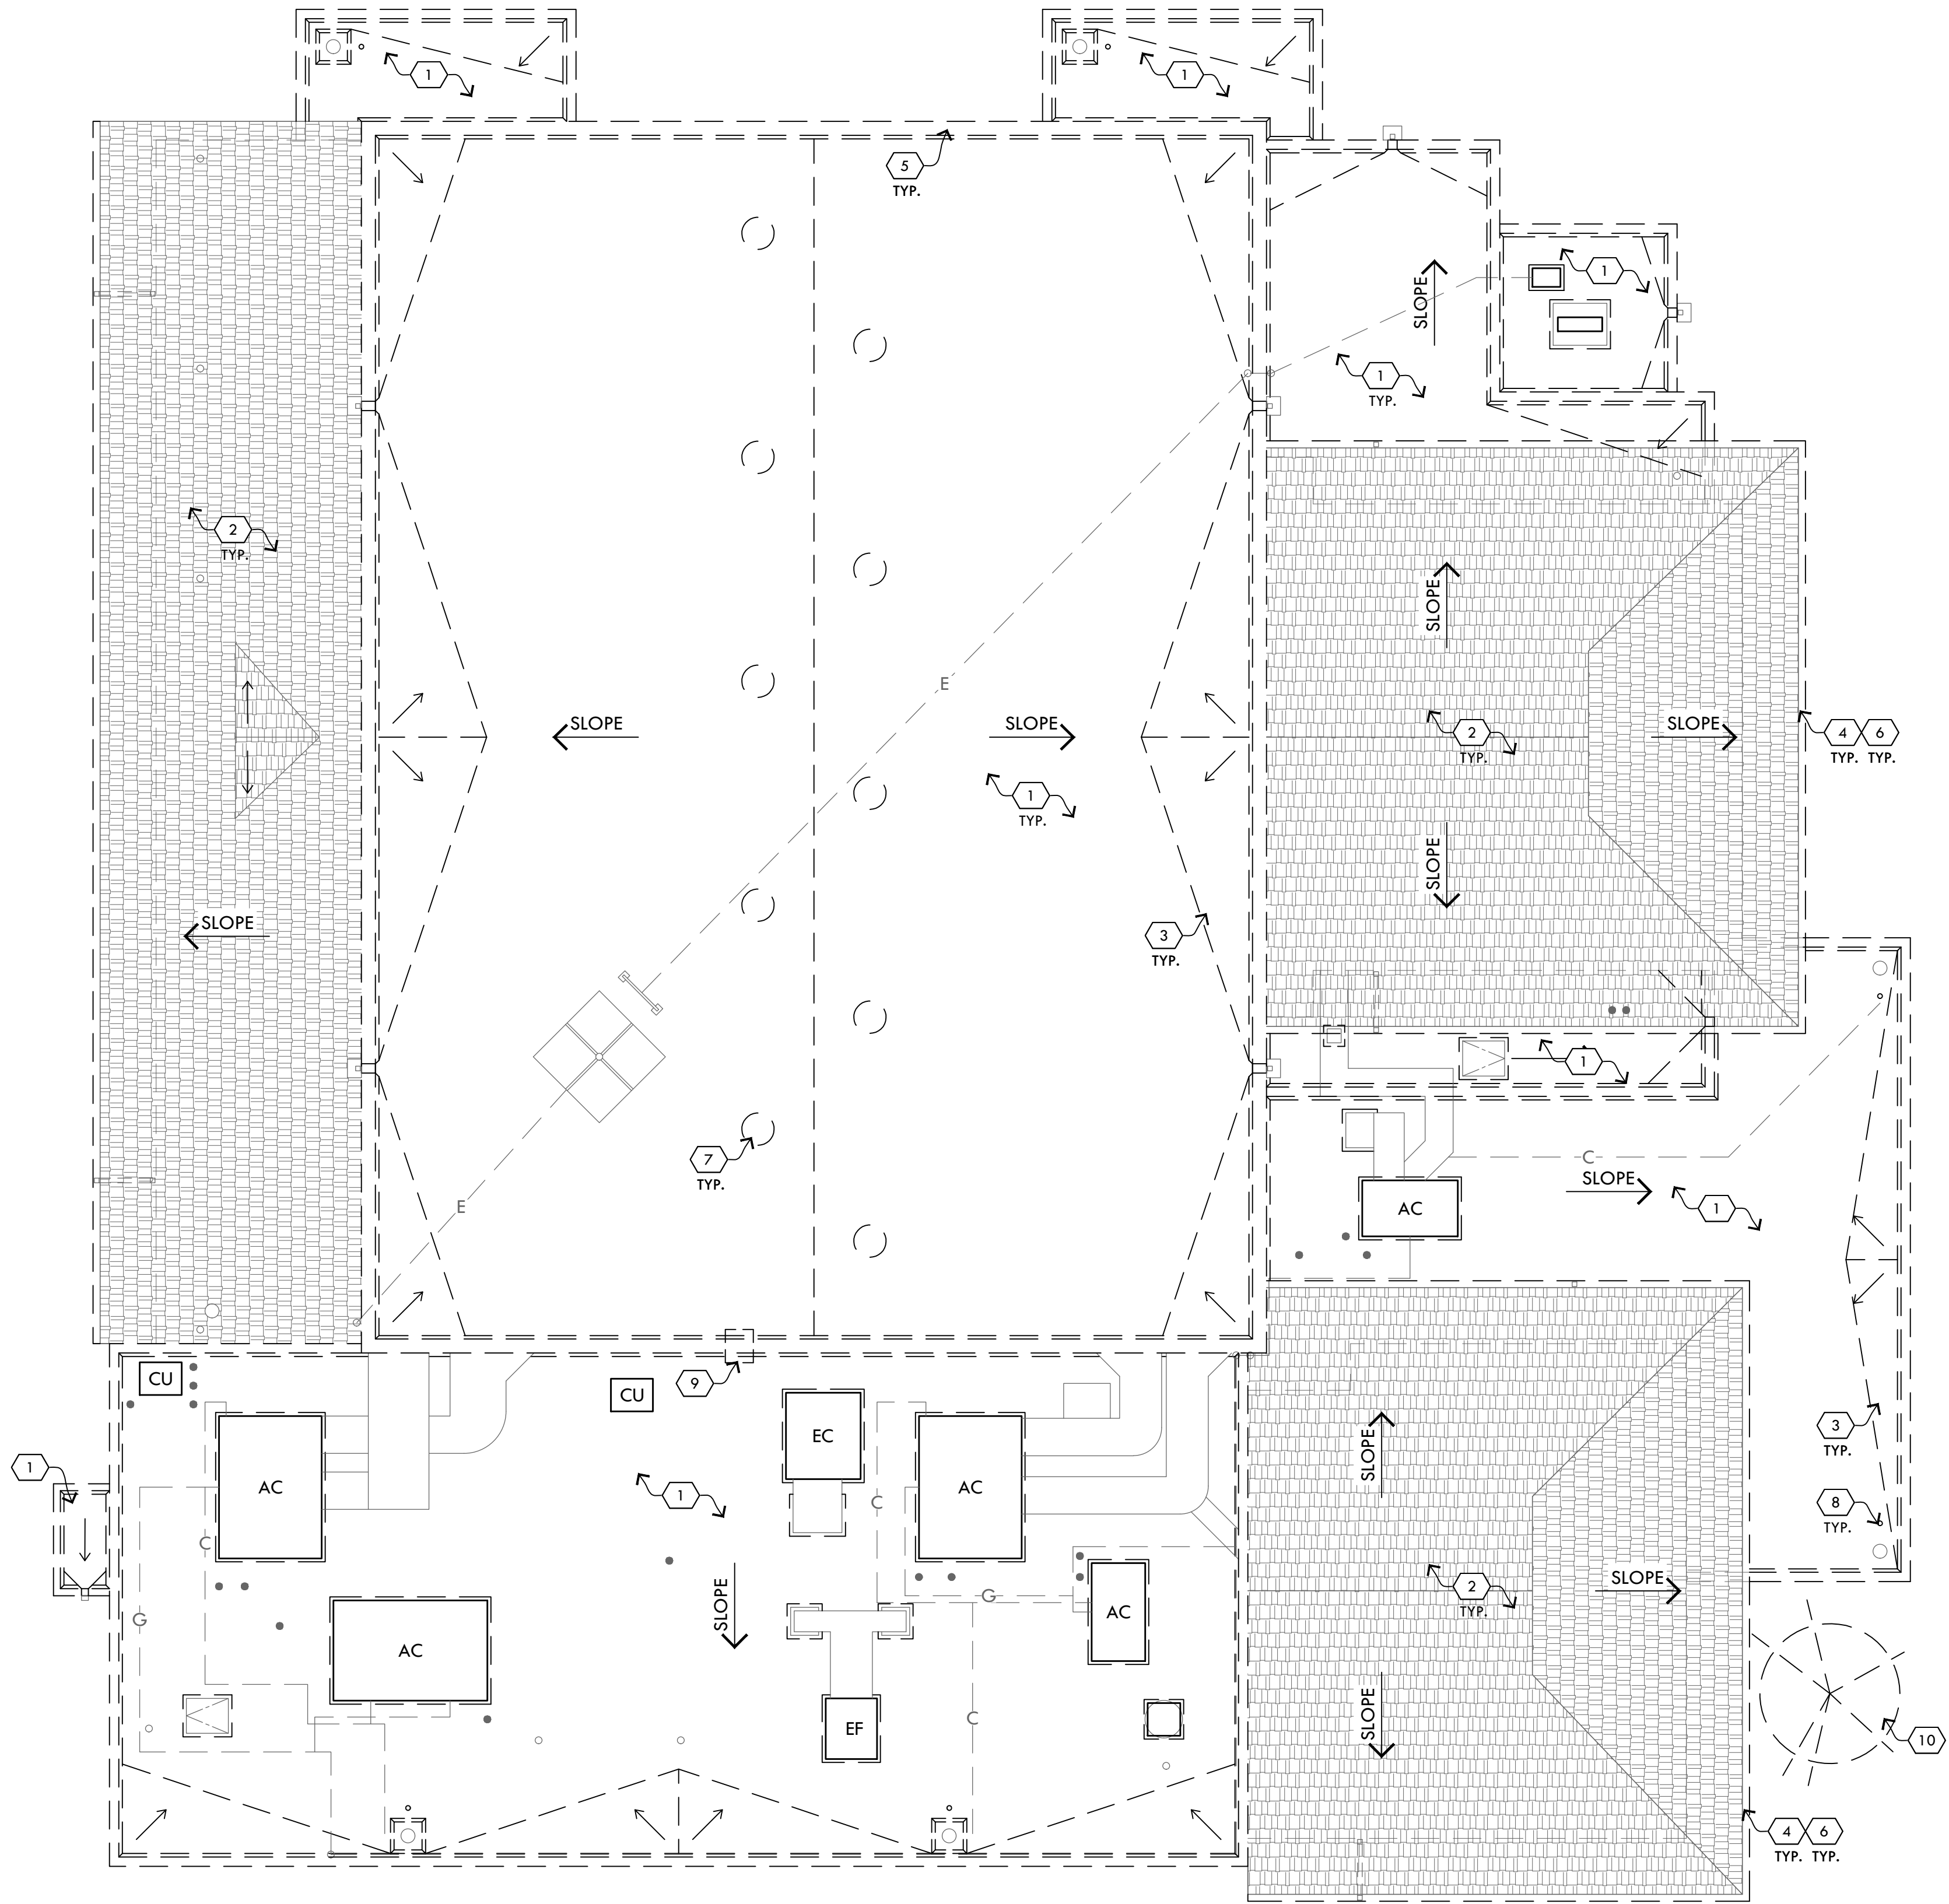

Demolition Roof Plan
1" = 10'-0" 0 10' 30'

Demolition General Notes

- BUILDING AND SITE WILL BE OCCUPIED DURING CONSTRUCTION.
- EXISTING CONDITIONS SHOWN ARE APPROXIMATE. CONTRACTOR SHALL FIELD VERIFY ALL EXISTING CONDITIONS.
- CONDITIONS SHOWN ARE FOR GUIDANCE AND GENERAL INFORMATION ONLY. CONTRACTOR SHALL VISIT THE SITE AND EVALUATE ALL (E) CONDITIONS IN THE FIELD AND PROVIDE FOR ALL COSTS RELATED TO ACCOMPLISHING THE WORK. NOTES SHOWN ON THE CONTRACT DOCUMENTS SHALL BE INCORPORATED INTO THE PROJECT AT ALL APPROPRIATE LOCATIONS, WHETHER OR NOT SPECIFICALLY REFERENCED.
- CONTRACTOR SHALL PROTECT EXISTING STRUCTURES AND UTILITIES THAT ARE NOT TO BE REMOVED FROM INJURY OR DAMAGE RESULTING FROM THE CONTRACTOR'S OPERATION. CONTRACTOR SHALL REPLACE DAMAGED IMPROVEMENTS AND UTILITIES IN KIND.
- ALL SURFACES THAT AN EXISTING ITEM IS REMOVED FROM SHALL BE PATCHED AND REPAIRED TO MATCH ORIGINAL CONDITION OF THE SURFACE. IF THE SURFACE WILL BE ALTERED OR CHANGED BY THE CONSTRUCTION, PATCH AND REPAIR SHALL MEET CONSTRUCTION REQUIREMENTS. ALL PATCHING AND REPAIR SHALL BE WITH MATERIALS TO MATCH EXISTING U.N.O.
- CONTRACTOR SHALL LEAVE AREAS AFFECTED BY DEMOLITION AND SURROUNDING AREAS CLEAN AT THE END OF THE WORK DAY. SURROUNDING AREAS NOT INCLUDED IN THE SCOPE OR LIMITS OF WORK SHALL BE PROTECTED FROM DUST AND DEBRIS.
- REMOVE ROOFING DOWN TO STRUCTURAL DECK U.N.O.
- ALL ROOF EDGE FLASHING, COPINGS, BASE FLASHING, COUNTERFLASHING, ROOF PENETRATION FLASHING, AND PARAPET SCUPPERS TO BE REMOVED AND REPLACED U.N.O.
- REMOVE EXISTING PITCH POCKETS. PROVIDE LIQUID FLASHING MEMBRANE AT ALL PIPE/CONDUIT PENETRATIONS U.N.O.
- FOLLOWING THE REMOVAL OF EXISTING ROOFING MATERIAL, THE CONTRACTOR SHALL PERFORM A GENERAL CONDITION SITE INSPECTION. NOTIFY ARCHITECT OF CONDITIONS.
- REMOVE EXISTING SEALANT AT ALL WALL CONTROL JOINTS EXPOSED ABOVE THE ROOF AND PROVIDE NEW BACKER ROD AND SEALANT, CONTRACTOR TO FIELD VERIFY ALL LOCATIONS. INCLUDE FACE OF EXTERIOR WALL TO ADJACENT ROOF SURFACE. SEALANT SHALL MATCH EXISTING WALL COLOR WHERE VISIBLE.

Demolition Keynotes

- REMOVE (E) ROOFING TO STRUCTURAL DECK.
- REMOVE (E) ROOF TILES AND SALVAGE FOR RE-INSTALLATION. REMOVE (E) UNDERLAYMENT TO STRUCTURAL DECK.
- REMOVE (E) CRICKET.
- REMOVE (E) GUTTER.
- REMOVE (E) PARAPET COPING.
- REMOVE (E) SHEET METAL FASCIA.
- REMOVE (E) VENT HOOD.
- REMOVE (E) OVERFLOW DRAIN.
- REMOVE (E) ROOF LADDER.
- TRIM/REMOVE (E) TREE. COORDINATE WORK WITH DISTRICT.

Breckenridge
a r c h i t e c t s
p l a n n e r s

1735 e ft. lowell rd. #12
tucson arizona 85719
520.882.9944

Amphitheater Public Schools
Copper Creek Elementary School
MPR Roof Replacement
SFB Project No.: BRG-DSGN-00357



PROJECT NO:
17.14.72

DATE:
OCTOBER 2021

REVISION SCHEDULE		
DATE	DESCRIPTION	ISSUED TO
12/16/21	SFB COMMENTS	

DRAWN BY: SC
CHECKED BY: KDB

THIS DRAWING IS NOT TO BE USED FOR CONSTRUCTION PURPOSES UNTIL SEALED AND SIGNED BY ARCHITECTS OR BRECKENRIDGE GROUP INC. ARCHITECTS / PLANNERS, OR DESIGNATED CONSULTANTS.

DRAWINGS ARE COPYRIGHTED BY BRECKENRIDGE GROUP ARCHITECTS / PLANNERS. ANY REPRODUCTION OR REUSE WITHOUT WRITTEN PERMISSION IS STRICTLY FORBIDDEN.

Demolition
Roof Plan

A1.1

Construction General Notes

1.

CONTRACTOR SHALL TAPE CHARCOAL FILTER ROLLS OVER AIR INTAKES AND SHUT OFF FRESH AIR INTAKES ON HVAC UNITS DURING ROOFING INSTALLATION.
2.

PROVIDE CONDUIT WITH WEATHERHEAD AT CABLE PENETRATIONS AND LIQUID FLASH.
3.

REMOVE ALL WOOD AND PVC BLOCKS SUPPORTING DUCTWORK AND PIPING/CONDUIT. ALL DUCTWORK AND PIPING/CONDUIT ON ROOF SHALL BE SUPPORTED USING FACTORY FABRICATED ASSEMBLIES OF SOLID BASE POLYCARBONATE, HIGH DENSITY POLYPROPYLENE PLASTIC, RECYCLED TIRE RUBBER, OR GALVANIZED OR STAINLESS STEEL. SUPPORT ASSEMBLIES SHALL BE VERTICALLY ADJUSTABLE TO ACCOMMODATE SLOPE AND REQUIREMENTS OF THE PROJECT. COORDINATE WITH MANUFACTURER'S REPRESENTATIVE FOR SELECTIONS. FIELD VERIFY PIPING MATERIALS, SIZES, DUTY, LOCATIONS, AND ROOF TYPE. PROVIDE LOOSE-FITTING PIPE CLAMPS AT EACH PIPE SUPPORT; CLAMPS SHALL NOT RESTRICT MOVEMENT OF PIPING. APPROVED MANUFACTURERS: C-PORT/MIFAB (MIFAB.COM), MAPA (MAPAPRODUCTS.COM), MIRO (MIROIND.COM), PHP (PHPSD.COM). PROVIDE SLIP SHEET UNDER ALL EXISTING AND NEW SUPPORTS. EXTEND SLIP SHEET 1/2" BEYOND SUPPORTS.
4.

REMOVE ALL PLASTIC CONDENSATE DRAIN PIPING. ALL CONDENSATE DRAIN PIPING ON ROOF SHALL BE TYPE 'M' HARD DRAWN COPPER WITH WROUGHT COPPER FITTINGS. AT CONNECTION TO EACH UNIT PROVIDE DIELECTRIC UNION, TRAP, AND OPEN BREATHER TEE ON DISCHARGE SIDE OF TRAP. SLOPE DRAIN PIPING MIN. 1/4" PER FOOT TO APPROVED DRAINAGE LOCATION. PAINT WHITE.
5.

REMOVE ALL PLASTIC ROOF DRAIN DOMES AND PROVIDE CAST IRON ROOF DRAIN DOMES AT ALL ROOF DRAINS AND OVERFLOWS.
6.

TEST ALL ROOF DRAINS AND DOWNSPOUTS FOR CLOGS PRIOR TO JOB START. CONTRACTOR SHALL BE RESPONSIBLE FOR ALL ROOF DRAINS AND DOWNSPOUTS TO BE IN WORKING CONDITION UPON PROJECT COMPLETION, AND PRIOR TO FINAL INSPECTION.
7.

FLOOD COAT A 4-FOOT BY 6-FOOT AREA AROUND ALL DRAINS AND SCUPPERS AND A 3-FOOT WIDE AREA AROUND ROOF HATCHES AS RECOMMENDED BY ROOFING MANUFACTURER. FLOOD COAT BIRD BATH AREAS IF DISCOVERED.
8.

PROVIDE SLIP SHEET UNDER ALL (E) AND NEW SPLASH BLOCKS.
9.

RAISE (E) CONDUIT/PIPE PENETRATIONS AS REQUIRED SO THAT 8" MIN. FLASHING ABOVE ROOF IS PROVIDED. CONTRACTOR SHALL FIELD VERIFY ALL CONDITIONS.

Construction Keynotes

- 1

ROOFING ON COVER BOARD ON ROOF INSULATION.
- 2

REINSTALL (E) ROOF TILES ON NEW UNDERLAYMENT. REPLACE ALL MISSING, BROKEN, OR DAMAGED TILES.
- 3

TAPERED INSULATION CRICKET - SLOPE 1/2" IN 12" MIN.
- 4

PROVIDE TAPERED EDGE STRIP LAST 1'-0" AROUND SCUPPERS.
- 5

PROVIDE TAPERED INSULATION SUMP AT (E) ROOF DRAIN.
- 6

PROVIDE 12"x24" CONC. SPLASH BLOCK W/ SLIP SHEET AT (E) DOWNSPOUT.
- 7

PARAPET COPING CAP.
- 8

GUTTER.
- 9

CUT 4" DIA. OVERFLOW IN (E) CONDUCTOR HEAD.
- 10

SEAL (E) DUCT WALL PENETRATION.
- 11

REPLACE ROOF LADDER - PAINT.
- 12

COAT (E) HIGH WALL ABOVE ROOF W/ ELASTOMERIC COATING.
- 13

REMOVE WOOD SUPPORTS UNDER (E) CONDENSING UNIT AND PROVIDE COMPOSITE SUPPORTS W/ SLIP SHEET.
- 14

PROVIDE LOREN COOK MODEL 'PR' GRAVITY VENT ON NEW ROOF CURB TO ALLOW FOR PROPER FLASHING. MATCH (E) FREE OPEN AREA.
- 15

COORDINATE W/ OWNER TO TEMPORARILY RELOCATE (E) ANTENNA AND CONDUIT TO FACILITATE ROOF REPLACEMENT.
- 16

RELOCATE (E) WALL MOUNTED GAS PIPING TO ROOF AND PROVIDE ROLLER SUPPORTS W/ SLIP SHEET @ 8'-0" O.C. MAX. COORDINATE WORK W/ OWNER.
- 17

REMOVE (E) HOSE BIB AND PROVIDE WOODFORD MODEL 'RHY2-MS' ROOF HYDRANT.
- 18

PROVIDE OVERFLOW ROOF DRAIN AND DOME.
- 19

REPLACE (E) ELECTRICAL STAND W/ UNISTRUT FRAME ON SUPPORTS.
- 20

REMOVE & REINSTALL CONDUCTOR HEAD TO ENSURE PROPER SEAL AT BOTTOM OF PARAPET SCUPPER. SEAL CONDUCTOR HEAD TO WALL.

Symbol Legend


- o

PLUMBING STACK
- CONDUIT/PIPE PENETRATION
- EXHAUST
- PASSIVE VENT/AIR INTAKE
- AC

AIR CONDITIONING UNIT
- EC

EVAPORATIVE COOLER
- CU


CONDENSING UNIT
- FLOOD COAT
- SELF-ADHERING MEMBRANE ROOFING
- ROOF MOUNTED CONDUIT/PIPING

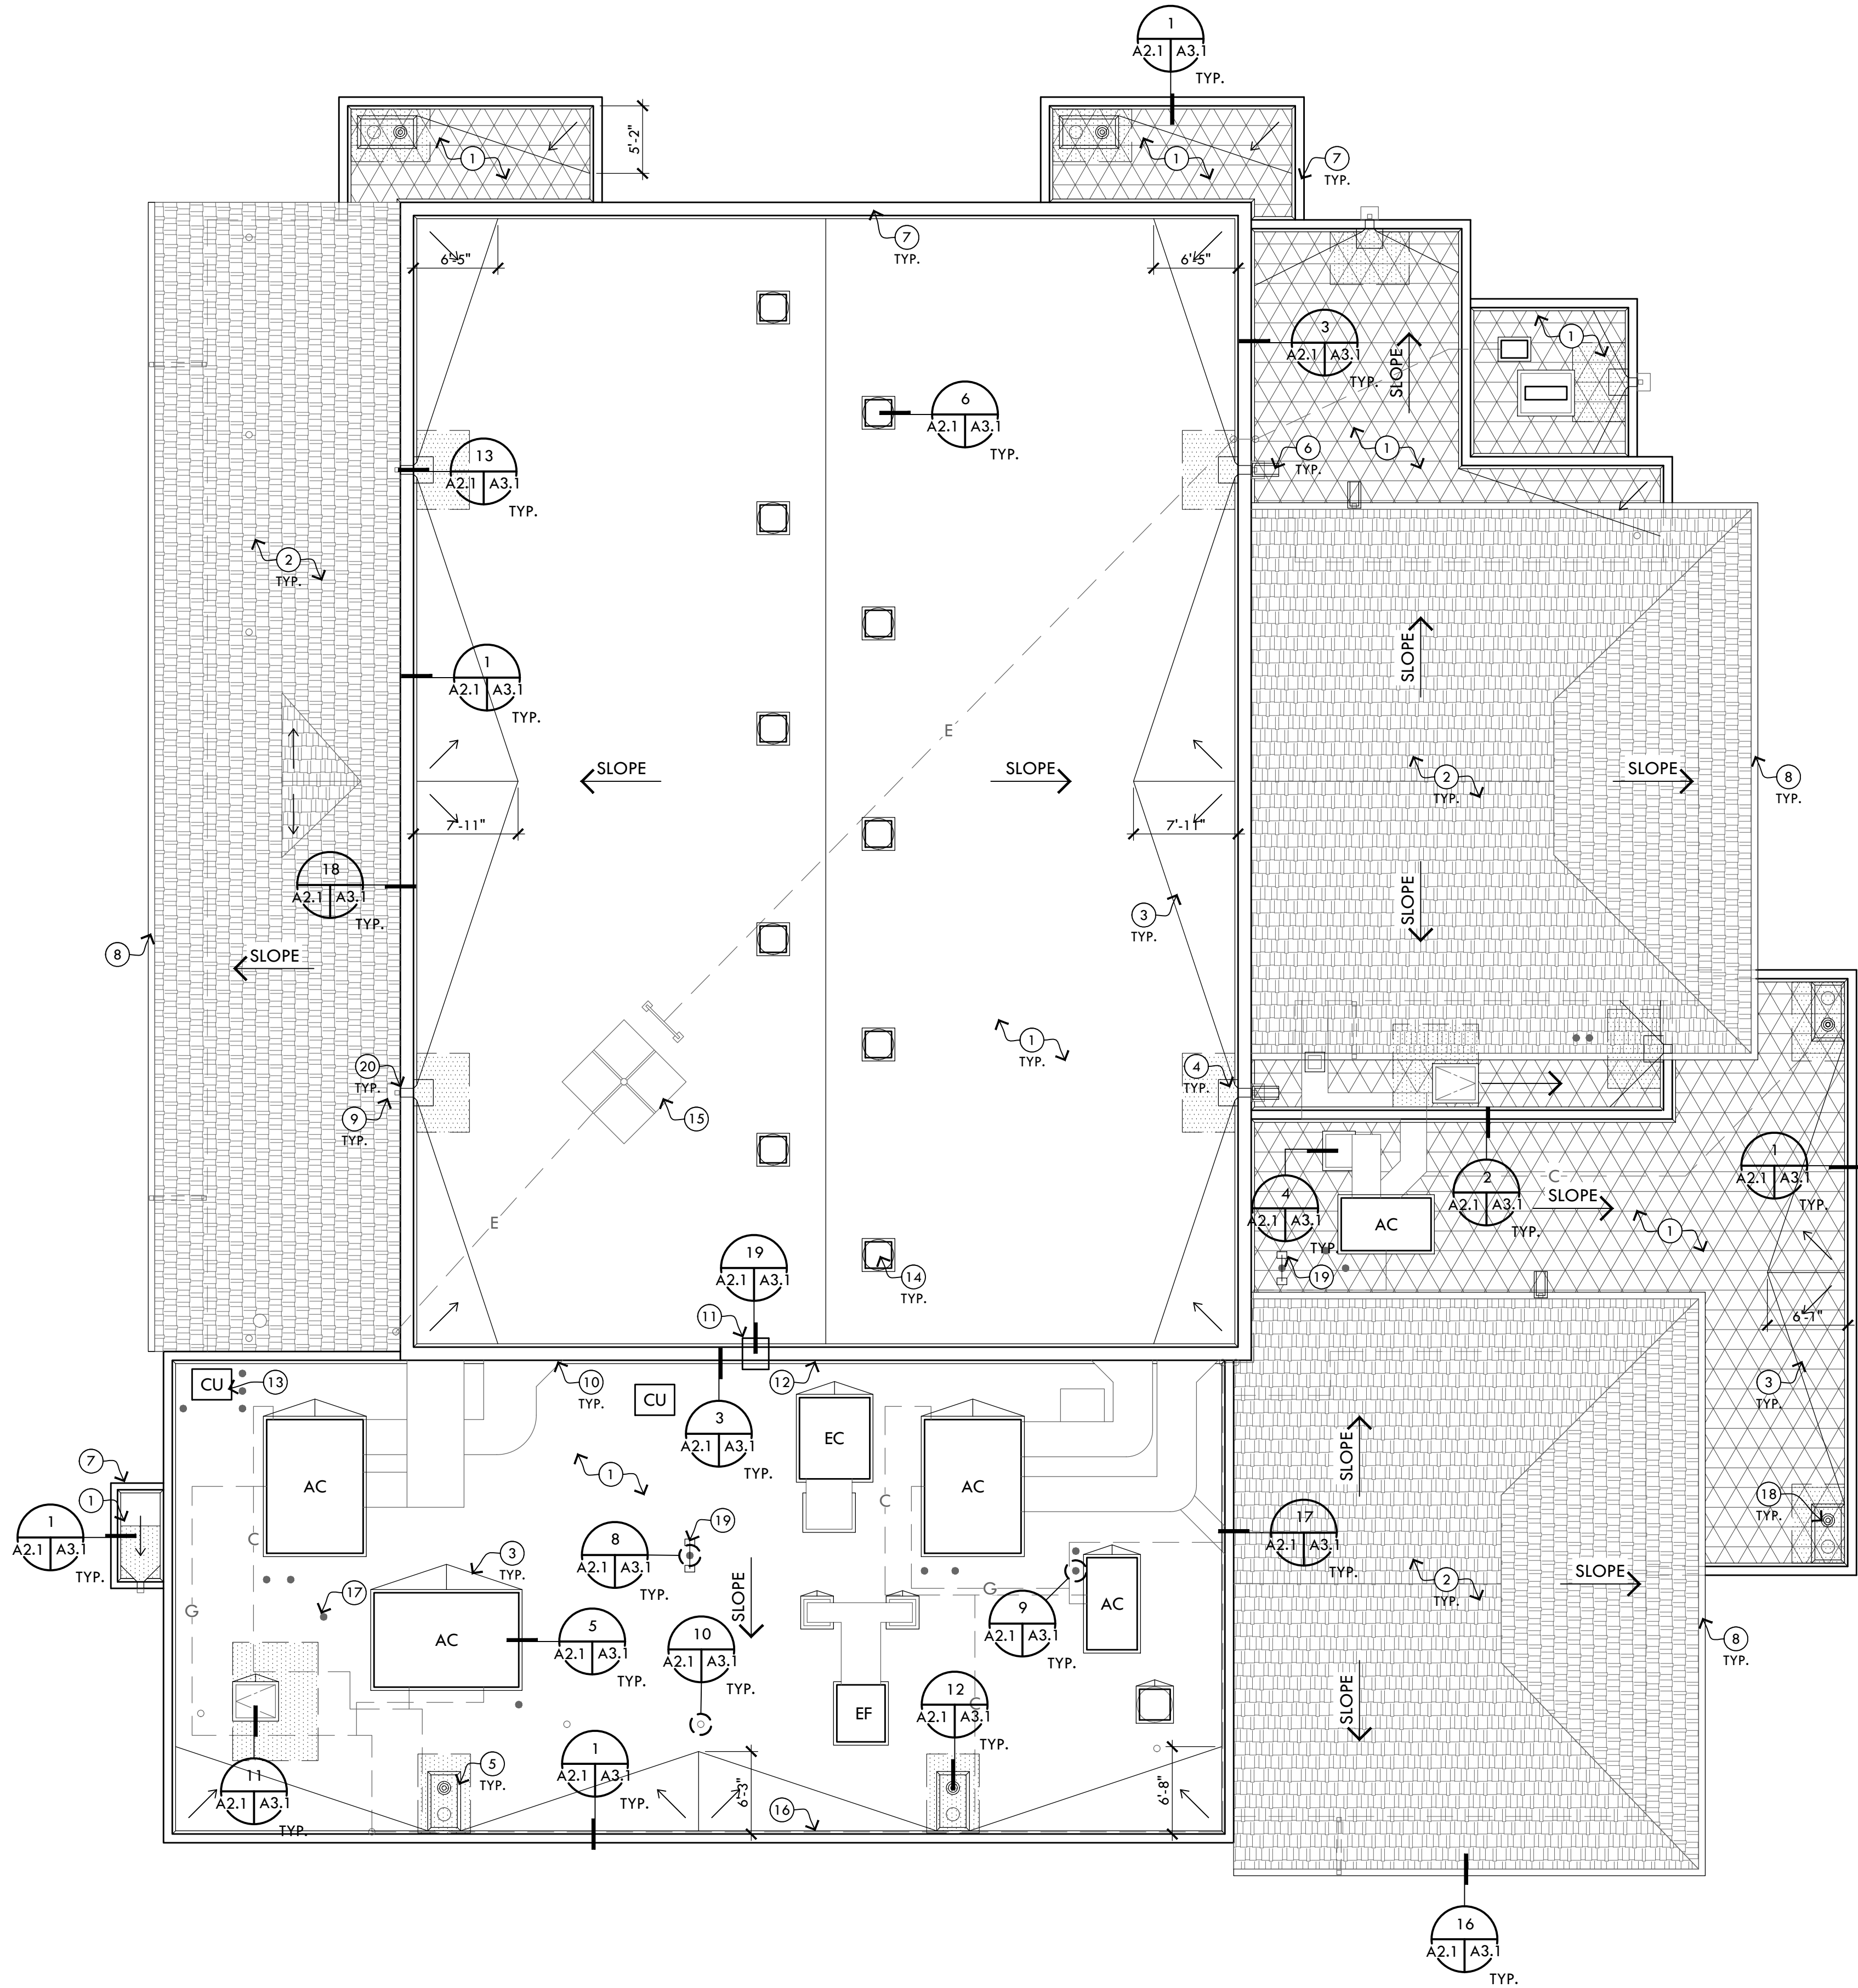

Breckenridge
architects
planners

1735 e ft. lowell rd. #12
tucson arizona 85719
520.882.9944

Amphitheater Public Schools
Copper Creek Elementary School
MPR Roof Replacement
SFB Project No.: BRG-DSGN-00357

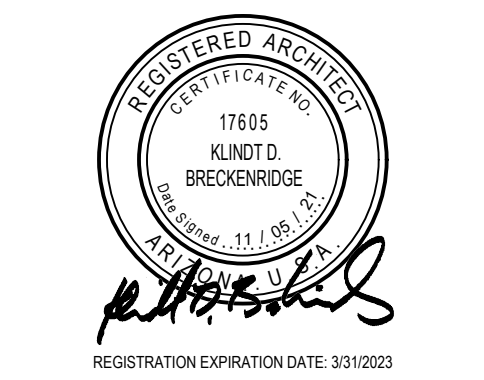

PROJECT NO.: 17.14.72
DATE: OCTOBER 2021

REVISION SCHEDULE		
#	DATE	DESCRIPTION

DRAWN BY: SC
CHECKED BY: KDB

THIS DRAWING IS NOT TO BE USED FOR CONSTRUCTION PURPOSES UNTIL SEALED AND SIGNED BY ARCHITECTS OF BRECKENRIDGE GROUP INC. ARCHITECTS / PLANNERS, OR DESIGNATED CONSULTANTS.

DRAWINGS ARE COPYRIGHTED BY BRECKENRIDGE GROUP ARCHITECTS / PLANNERS. ANY REPRODUCTION OR REUSE WITHOUT WRITTEN PERMISSION IS STRICTLY FORBIDDEN.

Roof Plan

A2.1

